



## Guidelines for Electronic Circulation of Planning & Development Applications

This document is intended to provide guidelines on the proper use of electronic materials that are circulated as part of the application review process.

- The information included in the circulation package may be subject to copyright and must only be used for the review of the submitted application.
- Application materials are provided to you for the specific and sole purpose of allowing (i) members of the Community Association Planning Committee and/or Board of Directors and (ii) members of the public who would be directly affected by the application's approval (collectively, the "Identified Recipients") to review and comment on the application for a development permit for a proposed project in your area of business/residence. Please note that use of these materials for any other purpose or making further reproduction or distribution beyond the Identified Recipients is strictly prohibited and may constitute an offense under the Copyright Act (Canada). Accordingly, any distribution of the materials to the Identified Recipients must be accompanied with the following instructions in writing:

"Application materials are provided to you for the specific and sole purpose of allowing you to review and comment on the application for a development permit for a proposed project in your area of business/residence. Please note that use of these materials for any other purpose or making further reproduction or distribution of them is strictly prohibited and may constitute an offense under the Copyright Act (Canada)."

The City will not be responsible or liable for any claim that may arise as a result of any misuse or unauthorized reproduction or distribution of the application materials by you or any Identified Recipients.

- Citizens who wish to view the plans can do so at the Municipal Building (800 Macleod Trail S.E.) by contacting either the File Manager or the Circulation Department at 403.268.5744 or [dp.circ@calgary.ca](mailto:dp.circ@calgary.ca)
- The information provided must not be made available on the internet.

Should anyone wish to obtain additional information regarding the application, please contact the File Manager directly.



# Application Notice DP2026-00391

January 28, 2026

A new Development Permit Application has been submitted at the below noted address(es), and we are sending this information for comments.

If you have questions or concerns related to this application, please contact the file manager directly at any point in the process.

## Application Details

**File Number:** DP2026-00391

**File Manager:** MARIA JIMENEZ MARTINEZ **Phone:** 403-312-2949 **eMail:** maria.jimenezmartinez@calgary.ca

**Address:** 438 8 ST NE

**Legal:** 4647V;115;11

**Land Use Bylaw:** 1P2007

**L.U.D.:** DC

**Community:** BRIDGELAND/RIVERSIDE

**Ward:** 09

**Application Description:** New: Secondary Suite (basement) - parking stall size

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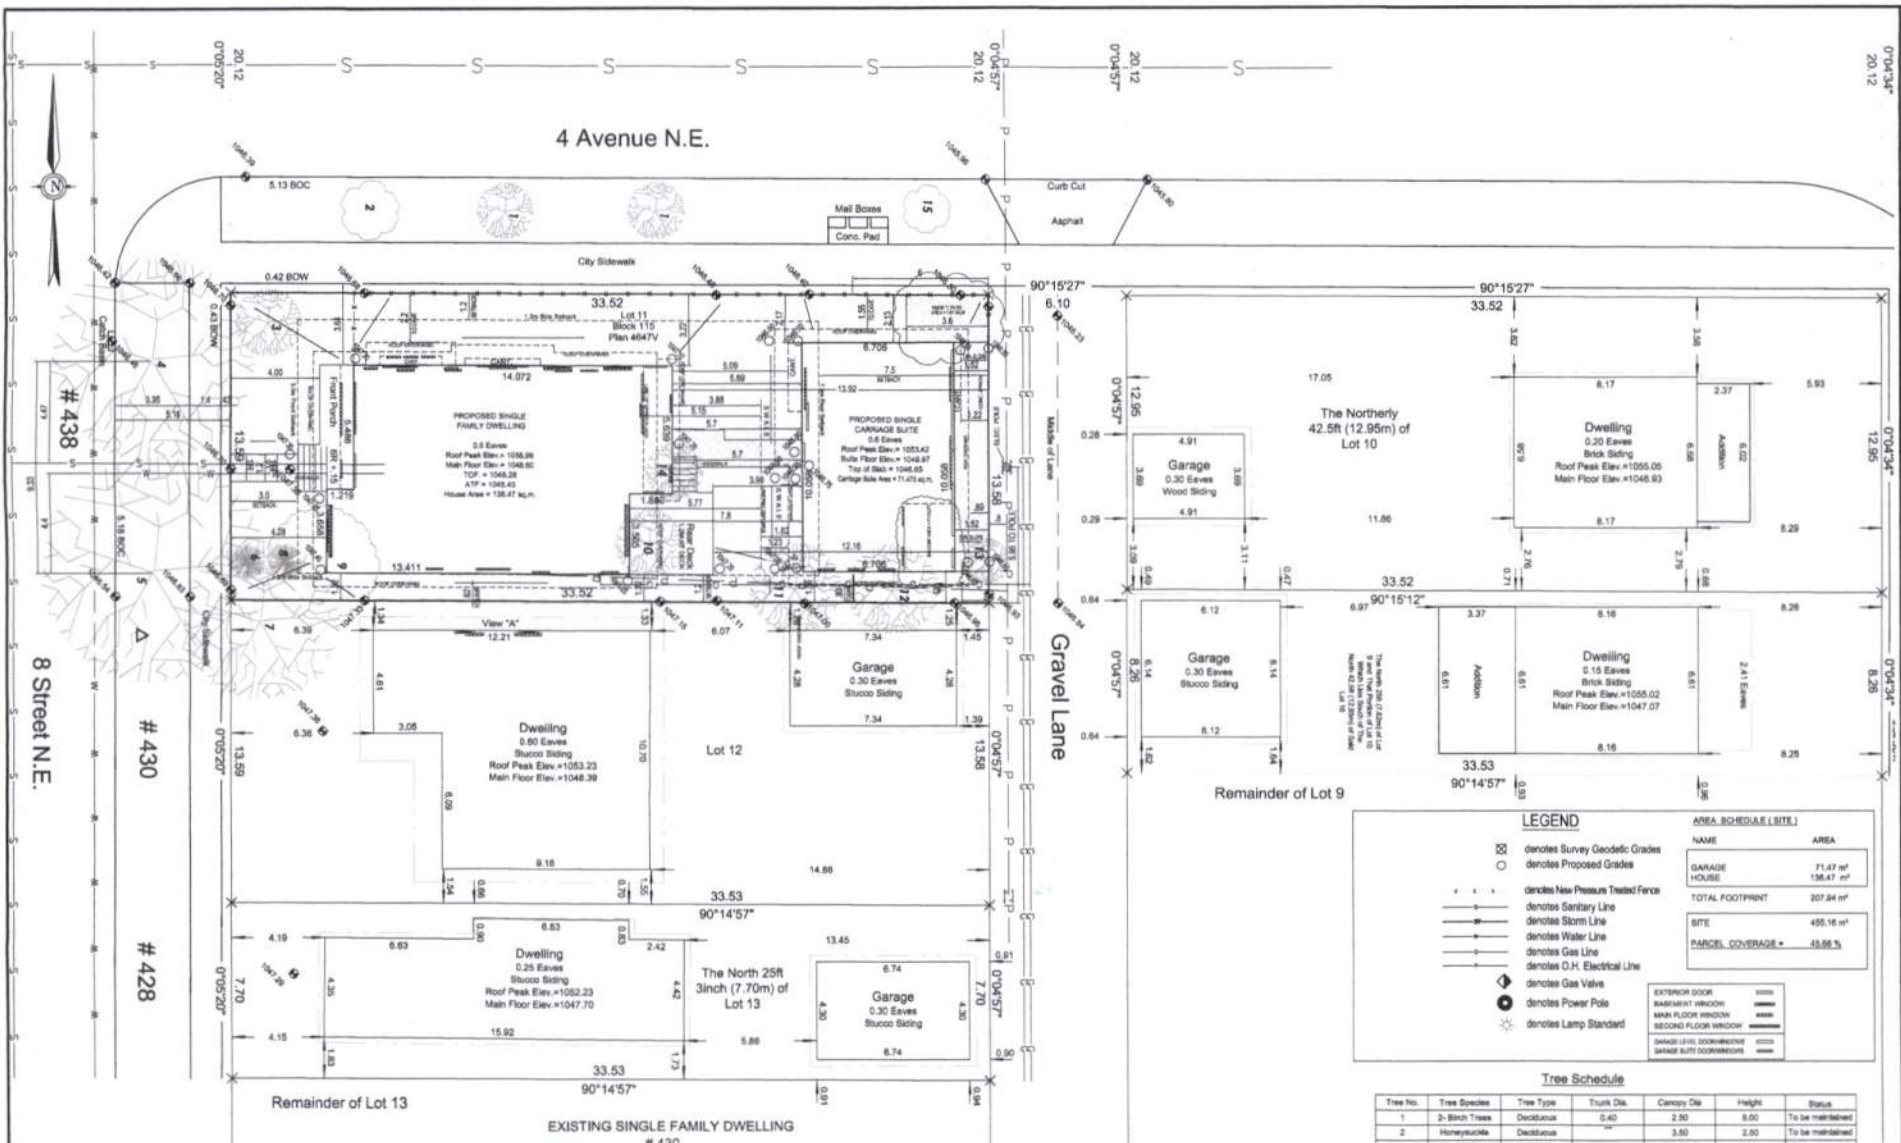
Thank you for taking the time to respond. Your input is greatly appreciated.

Please note that any written submissions made in response to the application will form part of the official record, and upon final decision of the application the correspondence will be available for public viewing.



Please submit your response through the [Development Map link](#).

**Comments are due by: February 18, 2026**

This information is released and may only be used for the sole purpose of your organizations meeting to discuss the recommendations of comments to be made to the City of Calgary on this permit.



**SITE PLAN/BLOCK PLAN**  
Scale: 1:100 ZONING: R-C2

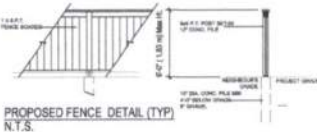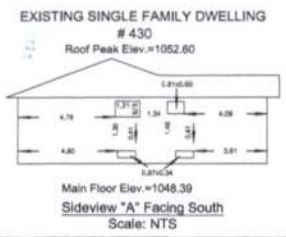

**LEGEND**

- ☒ denotes Survey Geodetic Grades
- denotes Proposed Grades
- denotes New Pressure Treated Fence
- denotes Sanitary Line
- denotes Storm Line
- denotes Water Line
- denotes Gas Line
- denotes O.H. Electrical Line
- ⚡ denotes Gas Valve
- ⚡ denotes Power Pole
- ☀ denotes Lamp Standard

**AREA SCHEDULE (SITE)**

| NAME                     | AREA                        |
|--------------------------|-----------------------------|
| GARAGE HOUSE             | 71.47 m <sup>2</sup>        |
| HOUSE                    | 136.47 m <sup>2</sup>       |
| <b>TOTAL FOOTPRINT</b>   | <b>207.94 m<sup>2</sup></b> |
| <b>SITE</b>              | <b>455.16 m<sup>2</sup></b> |
| <b>PARCEL COVERAGE =</b> | <b>45.68 %</b>              |

**EXTERIOR DOOR** [Symbol]

**BASEMENT WINDOW** [Symbol]

**MAIN FLOOR WINDOW** [Symbol]

**SECOND FLOOR WINDOW** [Symbol]

**GARAGE LEVEL DOWNDOOR** [Symbol]

**GARAGE SUITE DOWNDOOR** [Symbol]

**Tree Schedule**

| Tree No. | Tree Species   | Tree Type  | Trunk Dia. | Canopy Dia. | Height | Status           |
|----------|----------------|------------|------------|-------------|--------|------------------|
| 1        | 2-Birch Trees  | Deciduous  | 0.40       | 2.50        | 8.00   | To be maintained |
| 2        | Honeyuckle     | Deciduous  | ---        | 3.50        | 2.50   | To be maintained |
| 3        | Deciduous      | Deciduous  | 0.15       | 3.00        | 3.00   | To be removed    |
| 4        | Elm Tree       | Deciduous  | 0.85       | 9.00        | 8.00   | To be maintained |
| 5        | Elm Tree       | Deciduous  | 0.45       | 10.00       | 10.00  | To be maintained |
| 6        | Coniferous     | Coniferous | 0.08       | 1.50        | 13.00  | To be maintained |
| 7        | Neighbors Tree | Deciduous  | 0.80       | 7.00        | 8.00   | To be maintained |
| 8        | Coniferous     | Coniferous | 0.08       | 1.50        | 3.00   | To be maintained |
| 9        | Bush           | ---        | ---        | 8.00        | 3.00   | To be removed    |
| 10       | Deciduous      | Deciduous  | 0.10       | 3.00        | 3.00   | To be removed    |
| 11       | Deciduous      | Deciduous  | 0.15       | 4.00        | 4.00   | To be removed    |
| 12       | Deciduous      | Deciduous  | 0.15       | 4.00        | 4.00   | To be removed    |
| 13       | Deciduous      | Deciduous  | 0.10       | 2.00        | 2.00   | To be removed    |
| 14       | Deciduous      | Deciduous  | 0.15       | 2.00        | 3.00   | To be removed    |
| 15       | Honeyuckle     | Deciduous  | ---        | 1.00        | 1.70   | To be maintained |

CUSTOMER:

PROJECT & ADDRESS:  
438 8th Street N.E.  
CALGARY, AB  
LOT 11, BLK 115  
PLAN 4647V


DATE: November 5/2023

REVISION DATES:  
Jan 15/2024 - Revised plans as per DR dated Jan 8/2024  
March 4/2024 - Revised plans for revised garage  
March 27/2024 - Revised plans for cartage suite.  
April 19/2024 - Revised plans for city of Calgary.

DESIGNED BY: KELVIN HICKERSON  
A VERIFIED PROFESSIONAL ENGINEER IN THE PROVINCE OF ALBERTA  
I HEREBY CERTIFY THAT I AM THE DESIGNER OF THESE PLANS AND I AM RESPONSIBLE FOR THE DESIGN, CONSTRUCTION, OPERATION AND MAINTENANCE OF THE PROJECT AS SHOWN ON THESE PLANS.  
DRAWN BY: NW SCALE: AS NOTED

CONTACT:  
KELVIN HICKERSON  
403-463-1429

DRAWING: PAGE: 1 OF 7

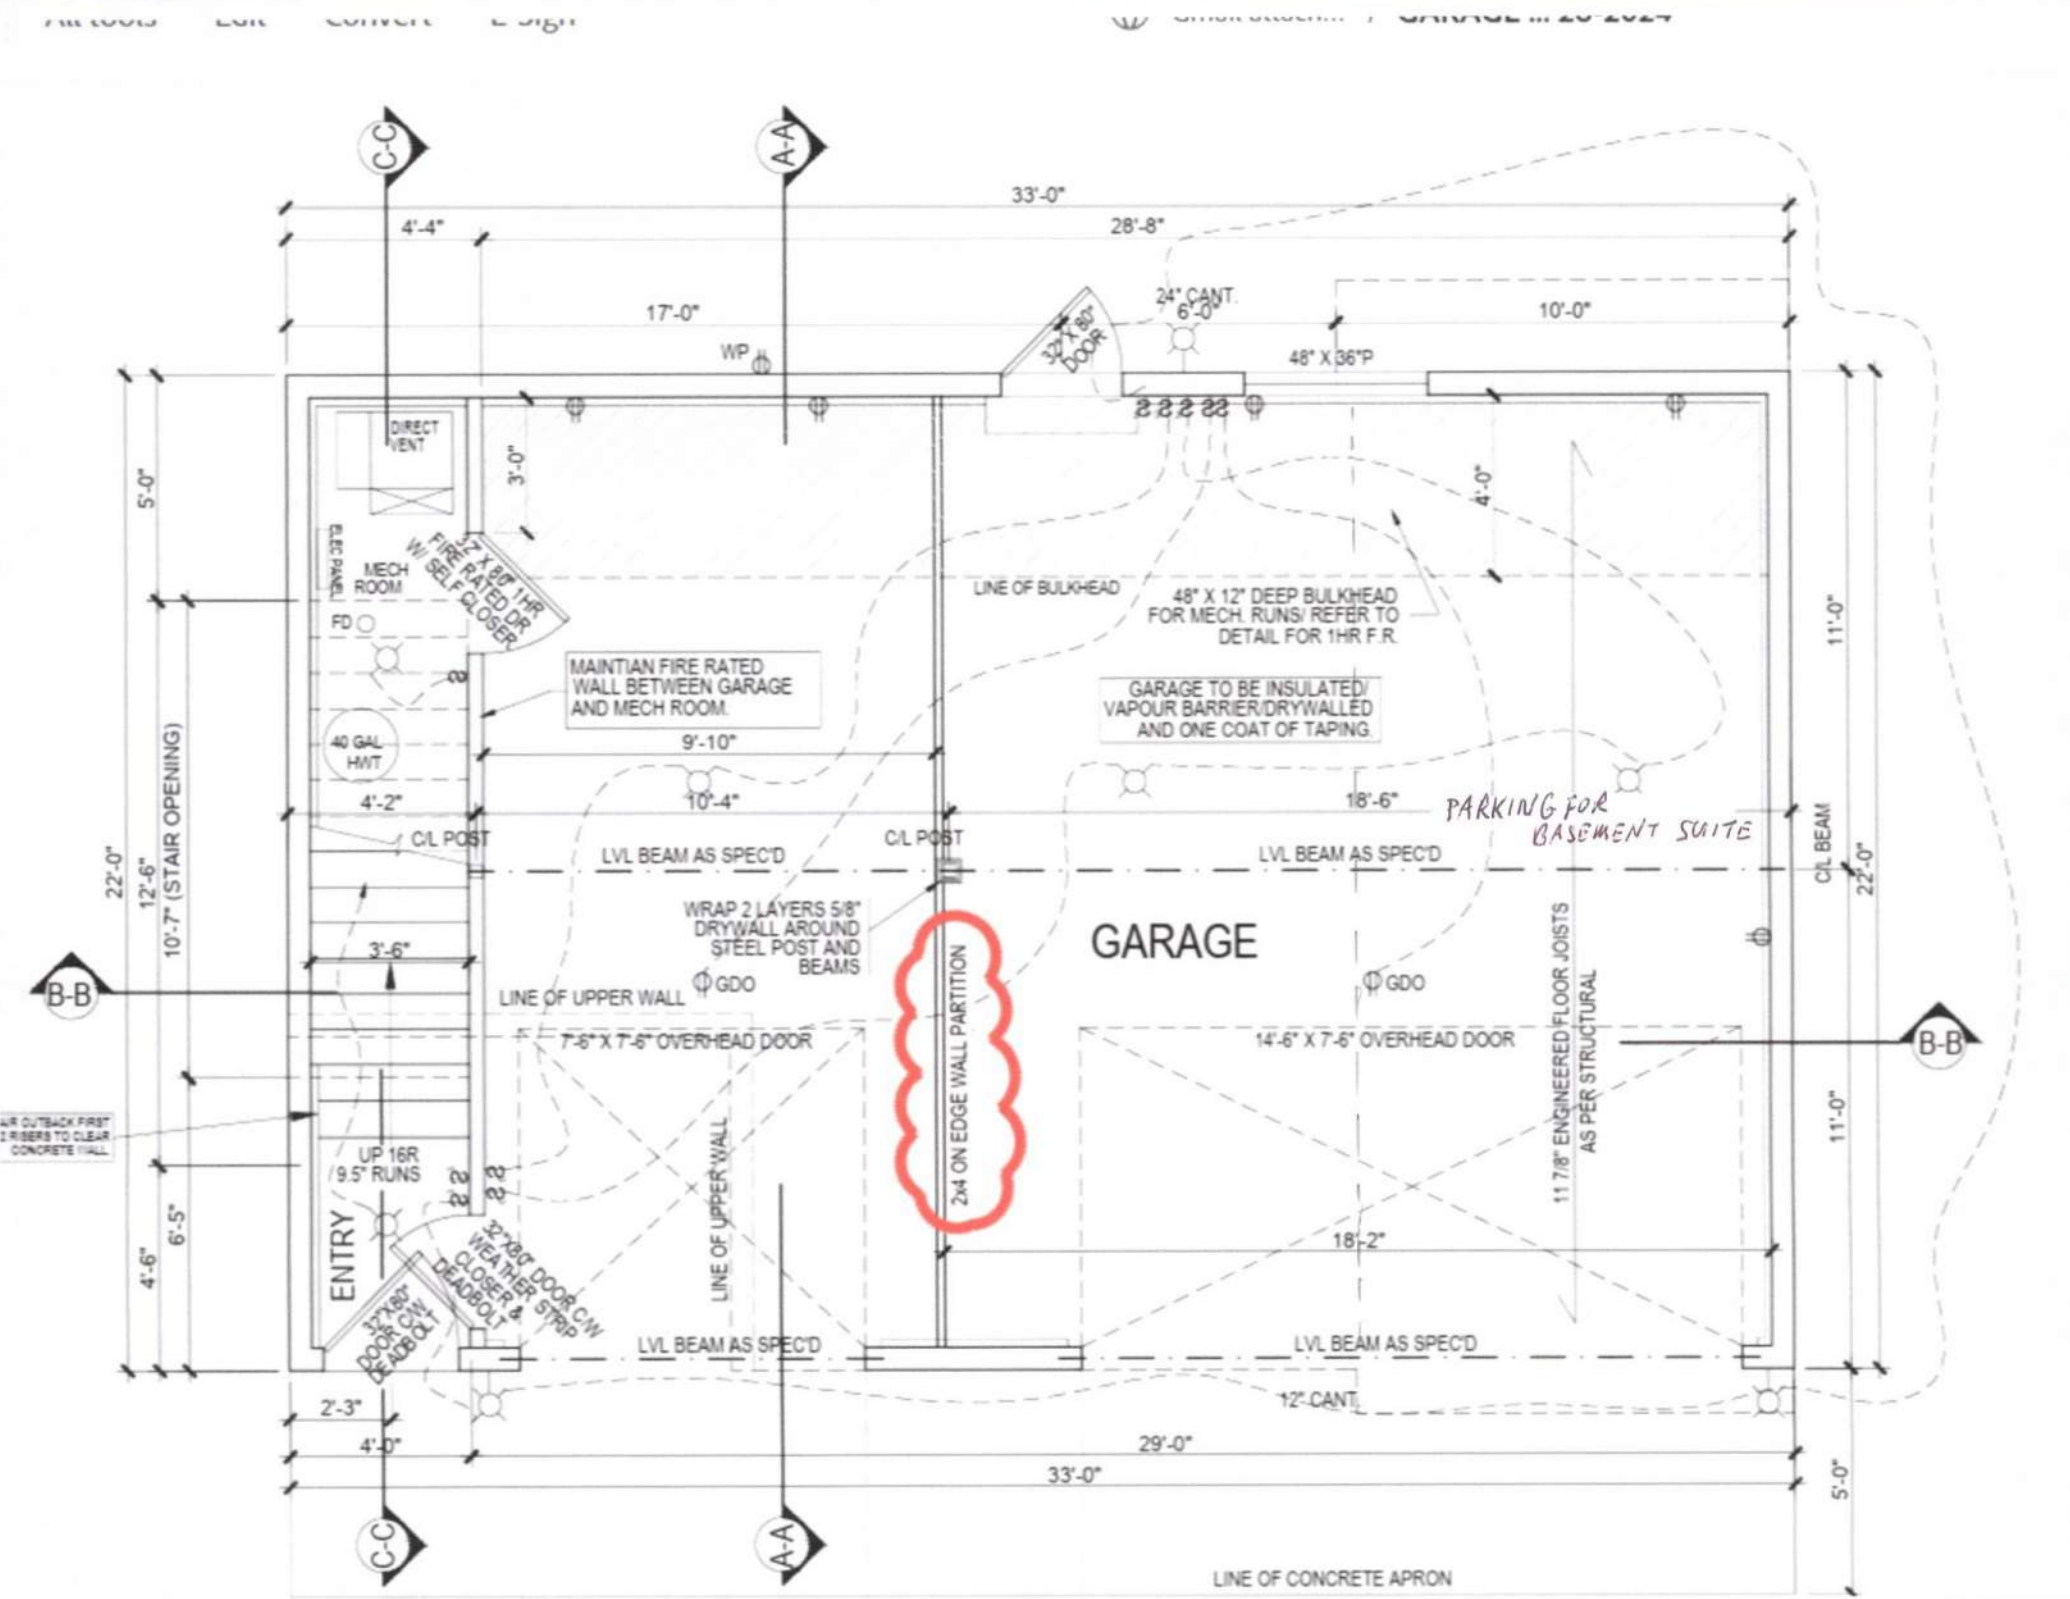

C-C

A-A

33'-0"

4'-4"

28'-8"

17'-0"

24" CANT.  
6'-0"

10'-0"

WP

48" X 36" P

5'-0"  
22'-0"  
12'-6" (STAIR OPENING)  
10'-7"  
4'-6"  
6'-5"  
4'-6"

DIRECT VENT  
MECH ROOM  
FD  
46 GAL HWT

18" X 36" FIBRE GLASS W/ BELF CLOSER  
FIBRE RATED DOOR

MAINTAIN FIRE RATED WALL BETWEEN GARAGE AND MECH ROOM.

LINE OF BULKHEAD

48" X 12" DEEP BULKHEAD FOR MECH. RUNS/ REFER TO DETAIL FOR 1HR F.R.

GARAGE TO BE INSULATED/ VAPOUR BARRIER/ DRYWALLED AND ONE COAT OF TAPING.

PARKING FOR BASEMENT SUITE

GARAGE

LVL BEAM AS SPEC'D

LVL BEAM AS SPEC'D

WRAP 2 LAYERS 5/8" DRYWALL AROUND STEEL POST AND BEAMS

LINE OF UPPER WALL

11 7/8" ENGINEERED FLOOR JOISTS AS PER STRUCTURAL

7-8" X 7-8" OVERHEAD DOOR

14-6" X 7-6" OVERHEAD DOOR

ENTRY

UP 16R 9.5" RUNS  
32" X 16" DOOR C/W WEATHER CLOSER & DEADBOLT

LVL BEAM AS SPEC'D

LVL BEAM AS SPEC'D

2'-3"

4'-0"

29'-0"

33'-0"

12" CANT.

C-C

A-A

LINE OF CONCRETE APRON

11'-0"

22'-0"

11'-0"

5'-0"

AIR OUTBACK FIRST 2 RISERS TO CLEAR CONCRETE WALL

STAGE: COMMENTS:  
 THE DRAWINGS EXCLUDE PROPERTY TO THE CONTRACTOR AND SHALL BE REPRODUCED IN ACCORDANCE WITH THE REQUIREMENTS OF THE CONTRACTOR.

PROJECT:  
 438, 8th Street N.E.  
 CALGARY, AB

Bridgeland

DATE:  
 FEBRUARY 19/2024


REVISION DATE:  
 March 4-2024 - Revised plans for reversed garage  
 March 27-2024 - Revised plans for carriage suite.

REVISION BY: SCALE:  
 IW 1/4" = 1'-0"


MODEL NAME:  
 2-Storey

CONTACT:  
 KELVIN HICKSON  
 403-852-1429

PAGE:  
 2 of 2

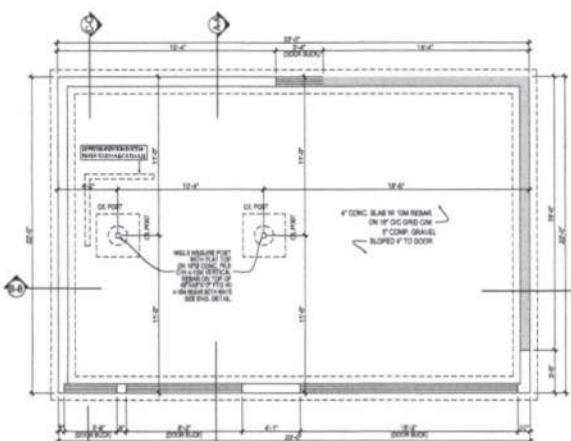


FOUNDATION PLAN

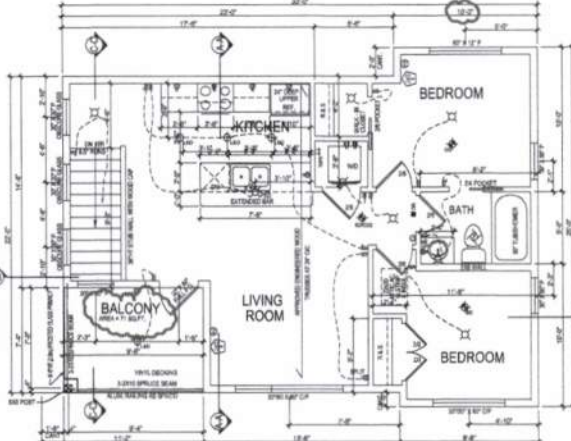

SUITE FLOOR PLAN

SUITE FLOOR AREA = 688 SQ.FT.  
 GROUND LEVEL AREA = 27 SQ.FT.  
 TOTAL SUITE AREA = 715 SQ.FT.

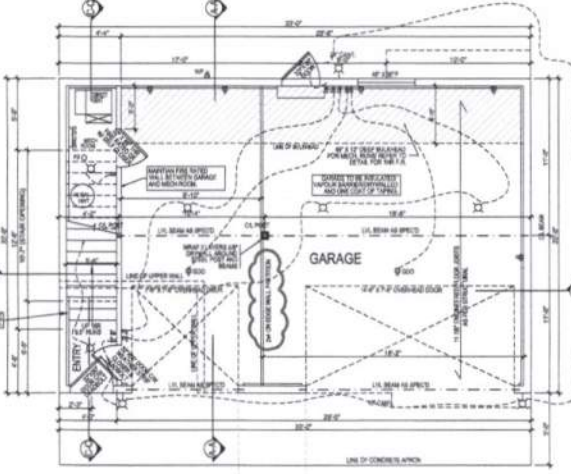


GARAGE FLOOR PLAN


GARAGE FLOOR AREA = 699 SQ.FT.

**ELECTRICAL LEGEND**


|   |                           |   |                           |
|---|---------------------------|---|---------------------------|
| ○ | OUTLET RECEPTACLE         | ○ | TELEPHONE OUTLET          |
| □ | SPECIAL PURPOSE OUTLET    | ○ | CABLE TELEVISION OUTLET   |
| ○ | GROUND FAULT INTERCEPTOR  | ○ | POWER IN UNCL. PLD OUTLET |
| ○ | WIRELESS PROOF RECEPTACLE | ○ | PHONE & COORDINATION      |
| ○ | SMOKE DETECTOR            | ○ | SMOKE DETECTOR            |
| ○ | WALL MOUNT LIGHT          | ○ | SMOKE DETECTOR WITH       |
| ○ | RECESSED LED POT          | ○ | TRIMMERSWITCH             |
| ○ | WALL DOWN LIGHT           | ○ | DOORBELL                  |
| ○ | WALL SWITCH               | ○ | WALL MOUNTED SPOONER      |
| ○ | 3 WAY WALL SWITCH         | ○ | HOBBER                    |
| ○ | 4 WAY WALL SWITCH         | ○ | CAT & OUTLET              |

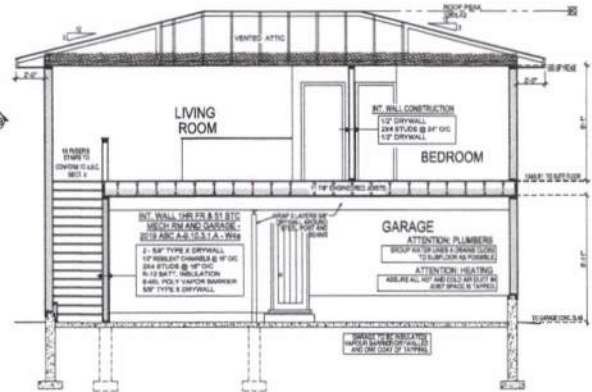

B-B CROSS SECTION

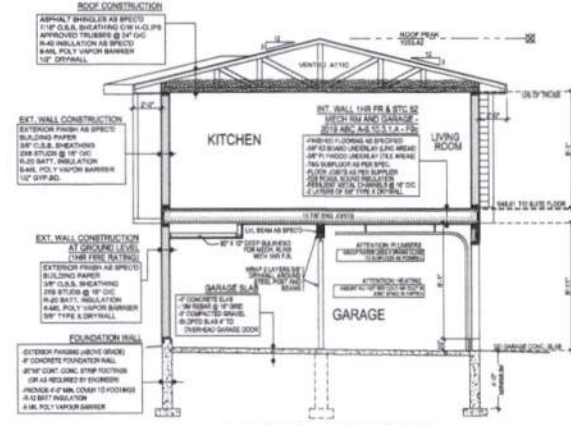

A-A CROSS SECTION

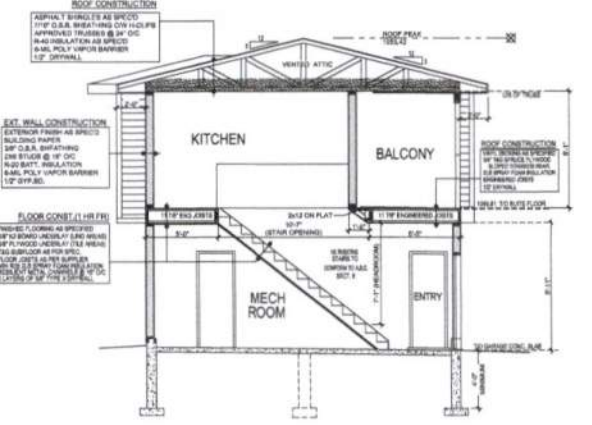

C-C CROSS SECTION

**ROOF CONSTRUCTION**  
 ASPHALT SHINGLES AS SPEC'D  
 1/2" O.S.B. SHEATHING ON 16" O.C. APPROVED TRUSSES @ 16" O.C.  
 R-19 INSULATION AS SPEC'D  
 1/2" GYP. WALL

**EXT. WALL CONSTRUCTION**  
 EXTENSION FROM AS SPEC'D BUILDING PAPER  
 1/2" O.S.B. SHEATHING  
 2" MIN. INSULATION  
 1/2" GYP. WALL


**FOUNDATION WALL**  
 4" CONCRETE FOUNDATION WALL  
 4" CONCRETE CONC. 10% FIBRE  
 OR AS REQUIRED BY ENGINEER  
 FINISHES TO FIN. CONGR. TO FOOTINGS  
 4" O.S.B. SHEATHING  
 4" O.S.B. POLY VAPOR BARRIER

**ROOF CONSTRUCTION**  
 ASPHALT SHINGLES AS SPEC'D  
 1/2" O.S.B. SHEATHING ON 16" O.C. APPROVED TRUSSES @ 16" O.C.  
 R-19 INSULATION AS SPEC'D  
 1/2" GYP. WALL


**EXT. WALL CONSTRUCTION**  
 EXTENSION FROM AS SPEC'D BUILDING PAPER  
 1/2" O.S.B. SHEATHING  
 2" MIN. INSULATION  
 1/2" GYP. WALL

**FLOOR CONSTRUCTION**  
 1/2" O.S.B. SHEATHING ON 16" O.C. APPROVED TRUSSES @ 16" O.C.  
 R-19 INSULATION AS SPEC'D  
 1/2" GYP. WALL

**BUILDING PERMIT**

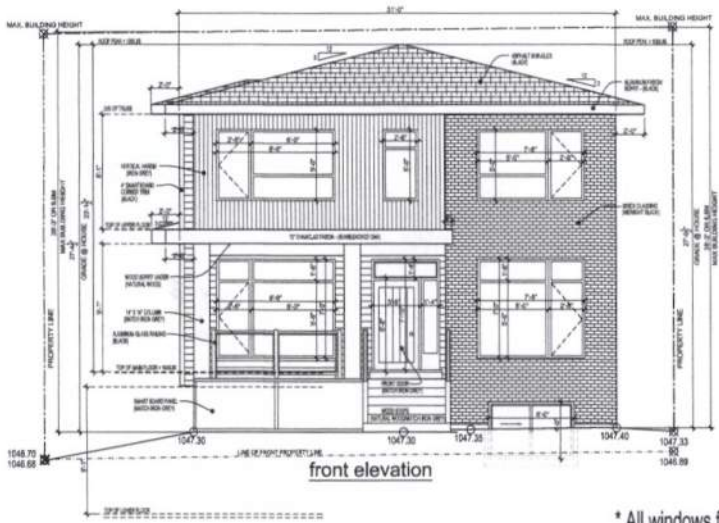


front elevation

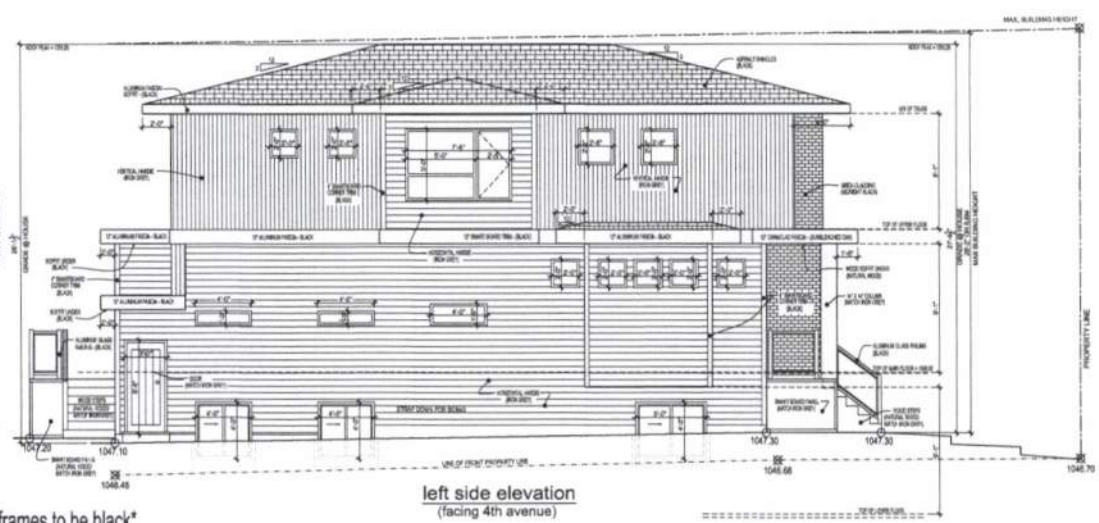


left side elevation  
(facing 4th avenue)

\* All windows frames to be black\*

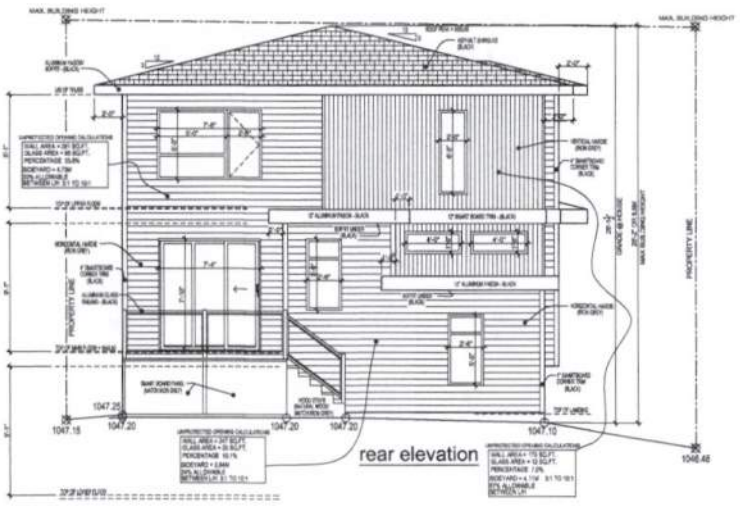


rear elevation

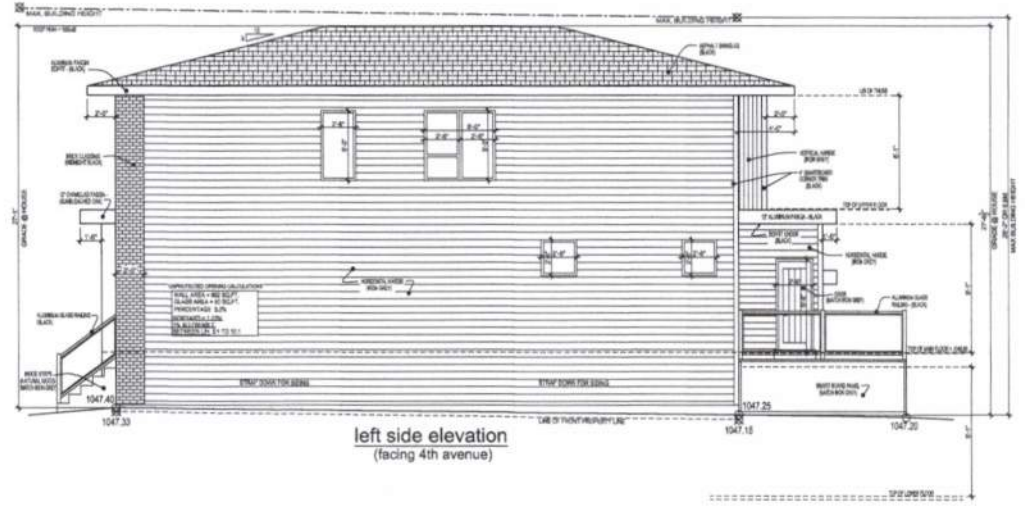

left side elevation  
(facing 4th avenue)

|  |  |
|--|--|
| <p>STAGE</p> <p>PROJECT: 438, 8th Street N.E. CALGARY, AB</p> <p>COMMENTS: THE DRAWINGS ARE THE PROPERTY OF THE ARCHITECT AND SHALL NOT BE REPRODUCED OR COPIED IN ANY MANNER WITHOUT THE WRITTEN CONSENT OF THE ARCHITECT.</p>  |  |
| <p>DATE: FEBRUARY 19/2024</p> <p>REVISION DATE: March 4-2024 - Revised plans for carriage garage March 27-2024 - Revised plans for carriage garage January 31-2025 - Add rail guard in stair window. July 4-2025 - Revise as per city deficiency comments. July 2025 Nov 23-2025 - Lower Development Plans for BP.</p> | <p>BRIDGELAND</p> <p>SCALE: 1/4" = 1'-0"</p> |
| <p>MODEL NAME: 2-Storey</p> <p>CONTACT: KELVIN HICKERSON 403-463-1429</p>  | <p>PAGE: 1 of 7</p>                          |

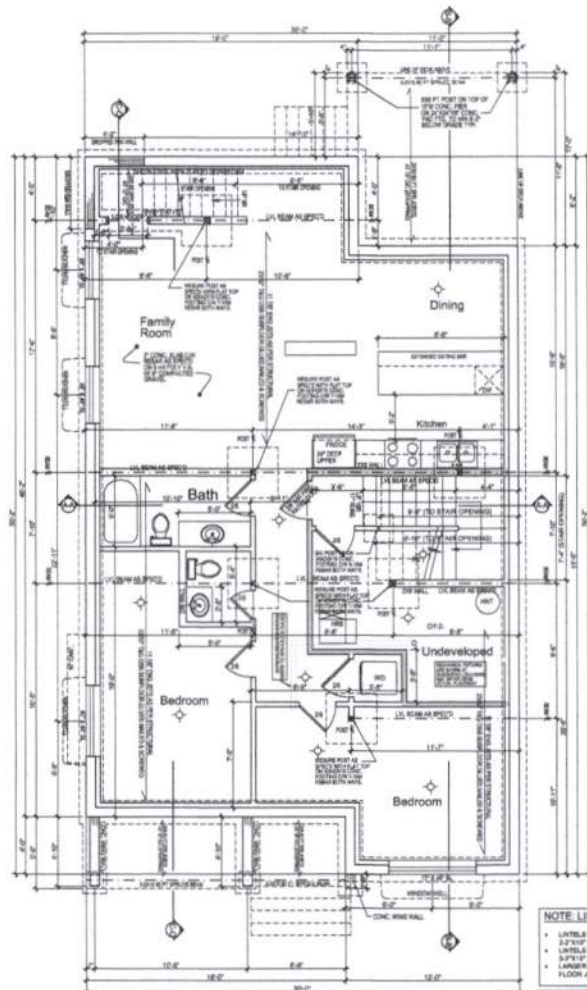

**lower floor plan**  
LOWER FLOOR AREA = 1094 SQ. FT.

**FINISH RATED WALL**  
1/2" GYPSUM BOARD  
5/8" MIN. BRICK ANCHORS  
3/4" MIN. STAINLESS STEEL  
1/2" MIN. STAINLESS STEEL  
4" MIN. CONCRETE  
6" MIN. STAINLESS STEEL  
6" MIN. STAINLESS STEEL

ALL GLASS PARTIAL STRUCTURAL ELEMENTS INCLUDING PARTIAL BEAMS AND COLUMNS MUST BE FULLY SIZED AND BY THE DESIGNER TO PROVIDE THE REQUIRED VIBRATION RESISTANCE RATIO.


**NOTE: LINTELS**

- LINTEL OVER OPENINGS  $\leq 8'$  TO BE 2" X 12" OR 2" X 10" DIMENSION
- LINTEL OVER OPENINGS  $> 8'$  TO BE 3" X 12" OR 3" X 10" DIMENSION
- LARGER OPENINGS TO BE DESIGNED BY FLOOR JOINT SUPPLIER

**NOTE:**  
USE 2" X 4" CLONED CELL SPRAY FOAM INSULATION FOR ALL CORNER JOINTS AND PEN JOINTS.  
1" PRESSURE TREATED

PROVIDE BLOCKS AND STAYS BEHIND ALL TUBS, BATHS FOR INSTALLATION @ 4" X 4" X 8" IN PLACE FOR INSULATION @ 2" X 2" X 8" IN PLACE OF TUBS. REMOVE TUBS. PROVIDE BLOCKS AND STAYS FOR UPPER & LOWER CABINET SUPPORT FOR INSULATION @ 2" X 2" X 8" FOR ALL PEN JOINTS.

|  |  |
|--|--|
| MINIMUM CHANGES BEHIND FOR INTERIUM DOORS<br>1" X 2" X 4" PALF | SPICED SOLID BIRCH<br>1" X 2" X 4" PALF<br>INCLUDES 2" X 2" X 8" |
| 1" X 2" DOOR: R.C. 1/2" X 2" X 8" TALL                         | 1" X 2" DOOR: R.C. 1/2" X 2" X 8" TALL                           |
| 1" X 2" DOOR: R.C. 1/2" X 2" X 8" TALL                         | 1" X 2" DOOR: R.C. 1/2" X 2" X 8" TALL                           |
| 1" X 2" DOOR: R.C. 1/2" X 2" X 8" TALL                         | 1" X 2" DOOR: R.C. 1/2" X 2" X 8" TALL                           |
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| 1" X 2" DOOR: R.C. 1/2" X 2" X 8" TALL                         | 1" X 2" DOOR: R.C. 1/2" X 2" X 8" TALL                           |
| 1" X 2" DOOR: R.C. 1/2" X 2" X 8" TALL                         | 1" X 2" DOOR: R.C. 1/2" X 2" X 8" TALL                           |
| 1" X 2" DOOR: R.C. 1/2" X 2" X 8" TALL                         | 1" X 2" DOOR: R.C. 1/2" X 2" X 8" TALL                           |
| 1" X 2" DOOR: R.C. 1/2" X 2" X 8" TALL                         | 1" X 2" DOOR: R.C. 1/2" X 2" X 8" TALL                           |

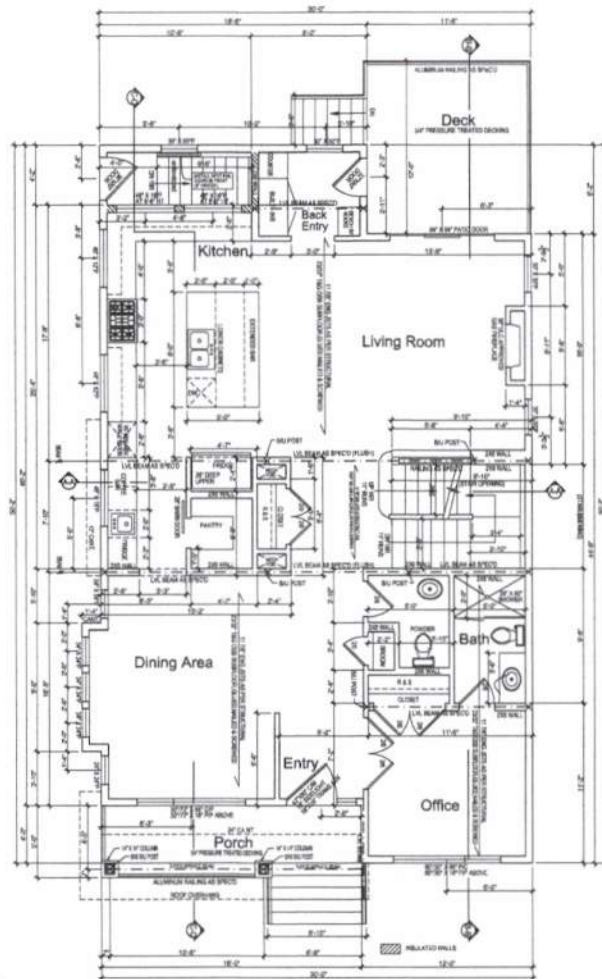

**main floor plan**  
MAIN FLOOR AREA = 1334 SQ. FT.  
TOTAL MANUPPER FLOOR AREA = 2088 SQ. FT.

**BUILDING PERMIT**

STAGE: \_\_\_\_\_

COMMENTS: \_\_\_\_\_

PROJECT: 438, 8th Street N.E. CALGARY, AB

Bridgeland

DATE: FEBRUARY 19/2024

REVISION DATE:  
March 4-2024 - Revised plans for reversed garage  
March 27-2024 - Revised plans for carriage built.  
January 31-2025 - Adds rail support in stair window.  
July 4-2025 - Revise as per city testimony comments. July 2025  
Nov 23-2025 - Lower Development Plans for BP.

DESIGNED BY: \_\_\_\_\_ SCALE: 1/4" = 1'-0"




DRAWN BY: IW

MODEL NAME: 2-Storey

CONTACT: KELVIN HICKERSON 403-453-1429

PAGE: 2 of 7






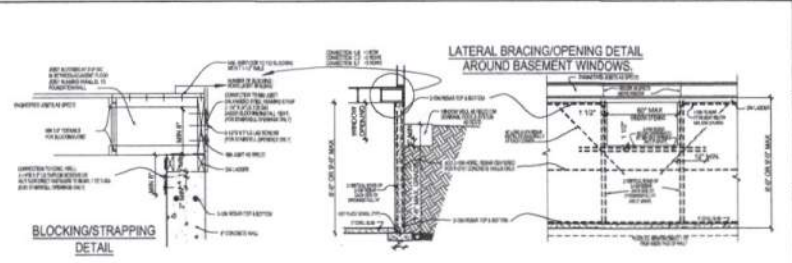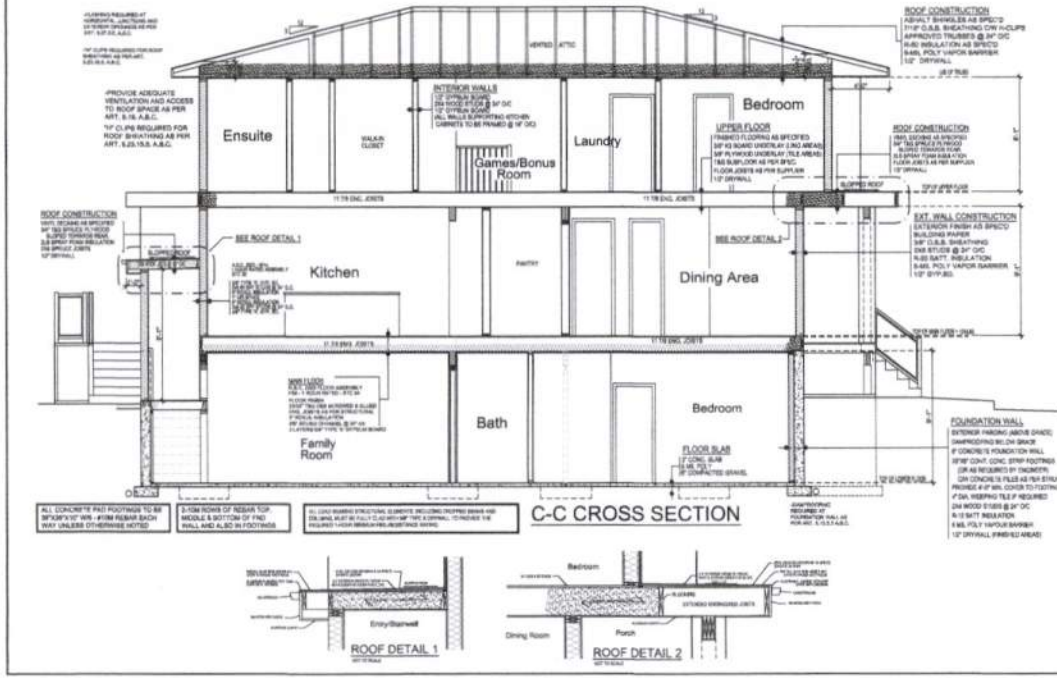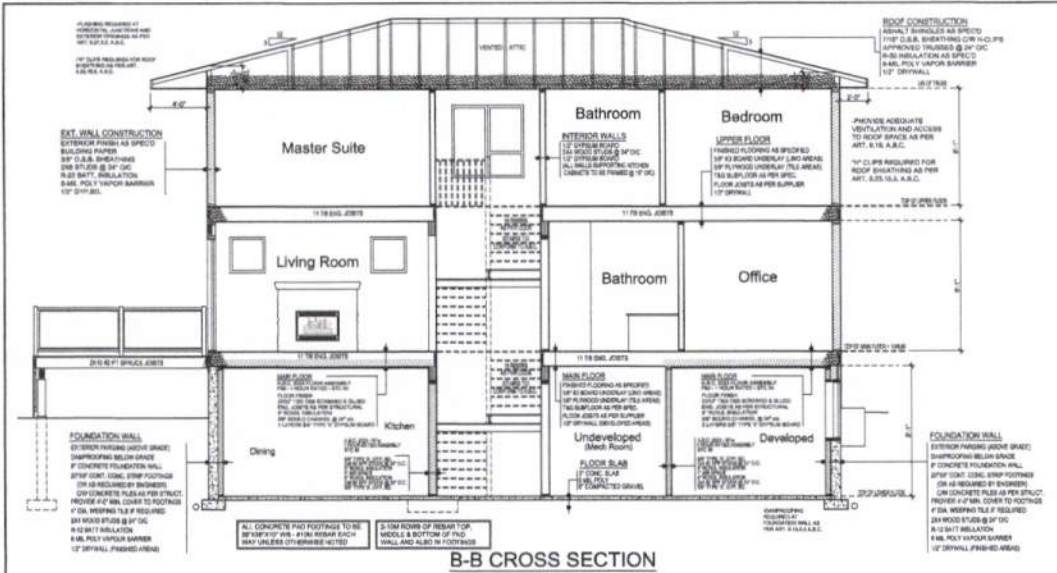

**LATERAL BRACING CONNECTIONS**

| TYPE | FACTORED LOAD (kN) | BRACING STRIP  | CONNECTION TO JOIST/COURSE | CONNECTION TO CONCRETE WALL                            |
|------|--------------------|----------------|----------------------------|--|
| A    | 1.200 (1.17 kN)    | 1" x 2" x 1/8" | 3" x 3" corner plate       | 1-2" x 4" x 7/8" lag screw or 1-2" x 4" x 2" lag screw |
| B    | 0.900              | 1" x 2" x 1/8" | 3" x 3" corner plate       | 1-2" x 4" x 2" lag screw or 1-2" x 4" x 7/8" lag screw |
| C    | 0.900              | 1" x 2" x 1/8" | 3" x 3" corner plate       | 1-2" x 4" x 7/8" lag screw or 1-2" x 4" x 2" lag screw |
| D    | 1.200 (1.17 kN)    | 1" x 2" x 1/8" | 3" x 3" corner plate       | 1-2" x 4" x 7/8" lag screw or 1-2" x 4" x 2" lag screw |
| E    | 1.200 (1.17 kN)    | 1" x 2" x 1/8" | 3" x 3" corner plate       | 1-2" x 4" x 7/8" lag screw or 1-2" x 4" x 2" lag screw |
| F    | 1.200 (1.17 kN)    | 1" x 2" x 1/8" | 3" x 3" corner plate       | 1-2" x 4" x 7/8" lag screw or 1-2" x 4" x 2" lag screw |

**ATTIC ACCESS DETAIL**

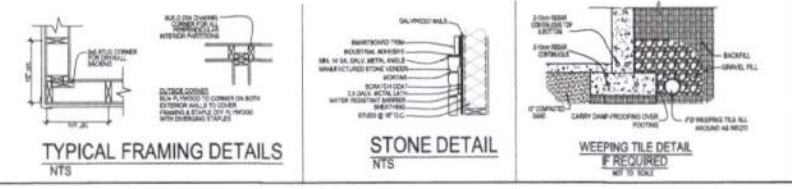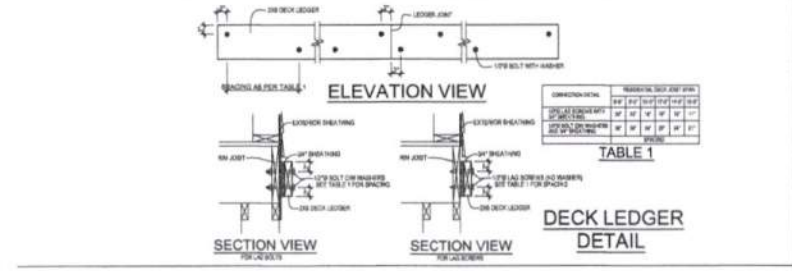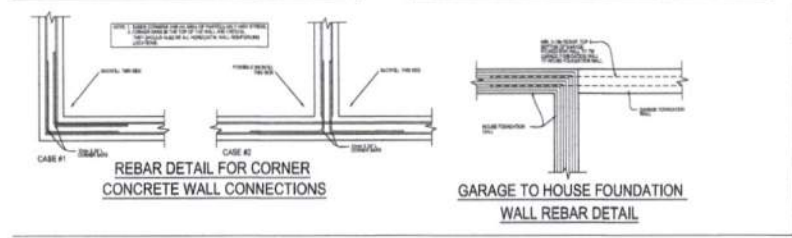

**BUILDING PERMIT**

PROJECT: 438, 8th Street N.E. CALGARY, AB

BRIDGELAND

DATE: FEBRUARY 19/2024


REVISION DATE: March 4-2024 - Revised plans for revised garage. March 27-2024 - Revised plans for carriage built. January 31-2025 - Add rail guard in stair window. July 4-2025 - Revise as per city deflection comments. July 2025 Nov 23-2025 - Lower Development Plans to 50'.

DRAWN BY: IW SCALE: 1/4" = 1'-0"

MODEL NAME: 2-Storey

CONTACT: KELVIN HICKERSON 403-463-1429


PAGE: 4 of 7

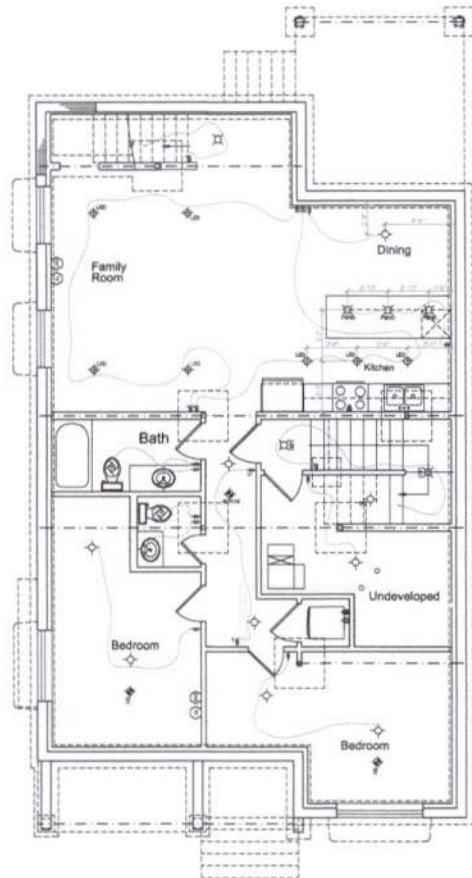

basement electrical plan




main floor electrical plan

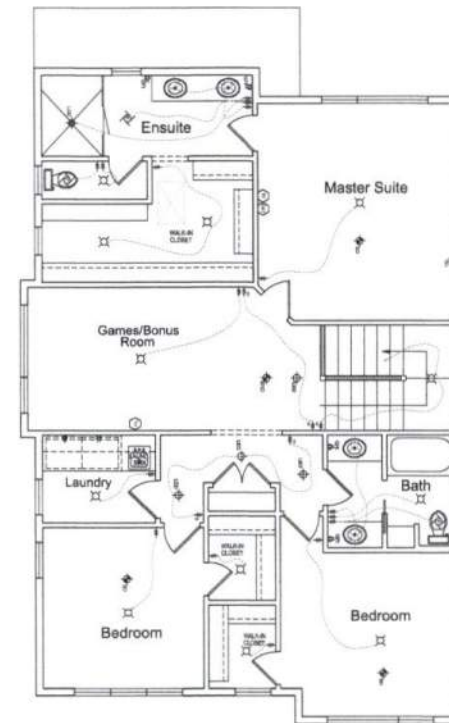


upper floor electrical plan

| ELECTRICAL LEGEND |                     |     |                        |
|-------------------|---------------------|-----|------------------------|
| 1                 | 20 AMP RECEPTACLE   | 10  | 10 AMP PANEL SERVICE   |
| 2                 | 30 AMP RECEPTACLE   | 11  | 15 AMP PANEL SERVICE   |
| 3                 | 40 AMP RECEPTACLE   | 12  | 20 AMP PANEL SERVICE   |
| 4                 | 50 AMP RECEPTACLE   | 13  | 25 AMP PANEL SERVICE   |
| 5                 | 60 AMP RECEPTACLE   | 14  | 30 AMP PANEL SERVICE   |
| 6                 | 70 AMP RECEPTACLE   | 15  | 35 AMP PANEL SERVICE   |
| 7                 | 80 AMP RECEPTACLE   | 16  | 40 AMP PANEL SERVICE   |
| 8                 | 90 AMP RECEPTACLE   | 17  | 45 AMP PANEL SERVICE   |
| 9                 | 100 AMP RECEPTACLE  | 18  | 50 AMP PANEL SERVICE   |
| 10                | 110 AMP RECEPTACLE  | 19  | 55 AMP PANEL SERVICE   |
| 11                | 120 AMP RECEPTACLE  | 20  | 60 AMP PANEL SERVICE   |
| 12                | 130 AMP RECEPTACLE  | 21  | 65 AMP PANEL SERVICE   |
| 13                | 140 AMP RECEPTACLE  | 22  | 70 AMP PANEL SERVICE   |
| 14                | 150 AMP RECEPTACLE  | 23  | 75 AMP PANEL SERVICE   |
| 15                | 160 AMP RECEPTACLE  | 24  | 80 AMP PANEL SERVICE   |
| 16                | 170 AMP RECEPTACLE  | 25  | 85 AMP PANEL SERVICE   |
| 17                | 180 AMP RECEPTACLE  | 26  | 90 AMP PANEL SERVICE   |
| 18                | 190 AMP RECEPTACLE  | 27  | 95 AMP PANEL SERVICE   |
| 19                | 200 AMP RECEPTACLE  | 28  | 100 AMP PANEL SERVICE  |
| 20                | 210 AMP RECEPTACLE  | 29  | 105 AMP PANEL SERVICE  |
| 21                | 220 AMP RECEPTACLE  | 30  | 110 AMP PANEL SERVICE  |
| 90                | 910 AMP RECEPTACLE  | 99  | 455 AMP PANEL SERVICE  |
| 91                | 920 AMP RECEPTACLE  | 100 | 460 AMP PANEL SERVICE  |
| 92                | 930 AMP RECEPTACLE  | 101 | 465 AMP PANEL SERVICE  |
| 93                | 940 AMP RECEPTACLE  | 102 | 470 AMP PANEL SERVICE  |
| 94                | 950 AMP RECEPTACLE  | 103 | 475 AMP PANEL SERVICE  |
| 95                | 960 AMP RECEPTACLE  | 104 | 480 AMP PANEL SERVICE  |
| 96                | 970 AMP RECEPTACLE  | 105 | 485 AMP PANEL SERVICE  |
| 97                | 980 AMP RECEPTACLE  | 106 | 490 AMP PANEL SERVICE  |
| 98                | 990 AMP RECEPTACLE  | 107 | 495 AMP PANEL SERVICE  |
| 99                | 1000 AMP RECEPTACLE | 108 | 500 AMP PANEL SERVICE  |
| 100               | 1010 AMP RECEPTACLE | 109 | 505 AMP PANEL SERVICE  |
| 101               | 1020 AMP RECEPTACLE | 110 | 510 AMP PANEL SERVICE  |
| 102               | 1030 AMP RECEPTACLE | 111 | 515 AMP PANEL SERVICE  |
| 198               | 1990 AMP RECEPTACLE | 207 | 995 AMP PANEL SERVICE  |
| 199               | 2000 AMP RECEPTACLE | 208 | 1000 AMP PANEL SERVICE |
| 200               | 2010 AMP RECEPTACLE | 209 | 1005 AMP PANEL SERVICE |
| 201               | 2020 AMP RECEPTACLE | 210 | 1010 AMP PANEL SERVICE |
| 202               | 2030 AMP RECEPTACLE | 211 | 1015 AMP PANEL SERVICE |
| 203               | 2040 AMP RECEPTACLE | 212 | 1020 AMP PANEL SERVICE |
| 204               | 2050 AMP RECEPTACLE | 213 | 1025 AMP PANEL SERVICE |
| 205               | 2060 AMP RECEPTACLE | 214 | 1030 AMP PANEL SERVICE |
| 206               | 2070 AMP RECEPTACLE | 215 | 1035 AMP PANEL SERVICE |
| 207               | 2080 AMP RECEPTACLE | 216 | 1040 AMP PANEL SERVICE |
| 208               | 2090 AMP RECEPTACLE | 217 | 1045 AMP PANEL SERVICE |
| 209               | 2100 AMP RECEPTACLE | 218 | 1050 AMP PANEL SERVICE |
| 210               | 2110 AMP RECEPTACLE | 219 | 1055 AMP PANEL SERVICE |
| 211               | 2120 AMP RECEPTACLE | 220 | 1060 AMP PANEL SERVICE |
| 212               | 2130 AMP RECEPTACLE | 221 | 1065 AMP PANEL SERVICE |
| 213               | 2140 AMP RECEPTACLE | 222 | 1070 AMP PANEL SERVICE |
| 214               | 2150 AMP RECEPTACLE | 223 | 1075 AMP PANEL SERVICE |
| 215               | 2160 AMP RECEPTACLE | 224 | 1080 AMP PANEL SERVICE |
| 216               | 2170 AMP RECEPTACLE | 225 | 1085 AMP PANEL SERVICE |
| 217               | 2180 AMP RECEPTACLE | 226 | 1090 AMP PANEL SERVICE |
| 218               | 2190 AMP RECEPTACLE | 227 | 1095 AMP PANEL SERVICE |
| 219               | 2200 AMP RECEPTACLE | 228 | 1100 AMP PANEL SERVICE |
| 220               | 2210 AMP RECEPTACLE | 229 | 1105 AMP PANEL SERVICE |
| 221               | 2220 AMP RECEPTACLE | 230 | 1110 AMP PANEL SERVICE |
| 222               | 2230 AMP RECEPTACLE | 231 | 1115 AMP PANEL SERVICE |
| 223               | 2240 AMP RECEPTACLE | 232 | 1120 AMP PANEL SERVICE |
| 224               | 2250 AMP RECEPTACLE | 233 | 1125 AMP PANEL SERVICE |
| 225               | 2260 AMP RECEPTACLE | 234 | 1130 AMP PANEL SERVICE |
| 226               | 2270 AMP RECEPTACLE | 235 | 1135 AMP PANEL SERVICE |
| 227               | 2280 AMP RECEPTACLE | 236 | 1140 AMP PANEL SERVICE |
| 228               | 2290 AMP RECEPTACLE | 237 | 1145 AMP PANEL SERVICE |
| 229               | 2300 AMP RECEPTACLE | 238 | 1150 AMP PANEL SERVICE |
| 230               | 2310 AMP RECEPTACLE | 239 | 1155 AMP PANEL SERVICE |
| 231               | 2320 AMP RECEPTACLE | 240 | 1160 AMP PANEL SERVICE |
| 232               | 2330 AMP RECEPTACLE | 241 | 1165 AMP PANEL SERVICE |
| 233               | 2340 AMP RECEPTACLE | 242 | 1170 AMP PANEL SERVICE |
| 234               | 2350 AMP RECEPTACLE | 243 | 1175 AMP PANEL SERVICE |
| 235               | 2360 AMP RECEPTACLE | 244 | 1180 AMP PANEL SERVICE |
| 236               | 2370 AMP RECEPTACLE | 245 | 1185 AMP PANEL SERVICE |
| 237               | 2380 AMP RECEPTACLE | 246 | 1190 AMP PANEL SERVICE |
| 238               | 2390 AMP RECEPTACLE | 247 | 1195 AMP PANEL SERVICE |
| 239               | 2400 AMP RECEPTACLE | 248 | 1200 AMP PANEL SERVICE |
| 240               | 2410 AMP RECEPTACLE | 249 | 12                     |

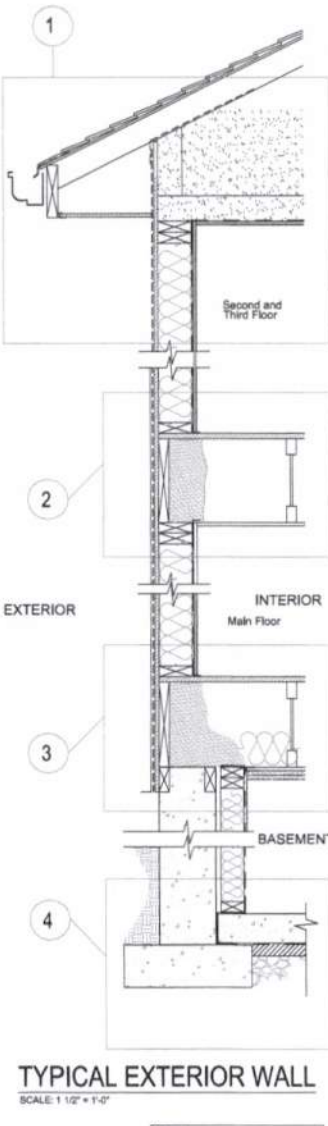


**TYPICAL EXTERIOR WALL**  
SCALE: 1 1/2" = 1'-0"


**NOTE:**  
- TAPE MEMBRANE BARRIER TO ALL METAL FLASHING.  
- ASSURE MIN 2% SLOPE ON ALL FLASHINGS.

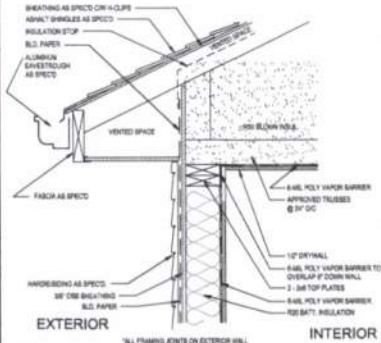


**1 EAVES/WALL CONNECTION DETAIL**  
SCALE: 1 1/2" = 1'-0"

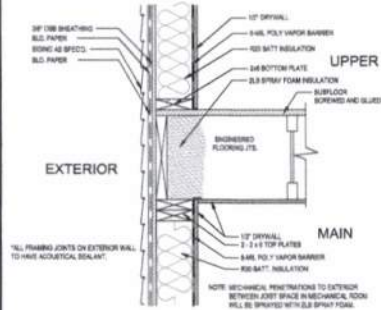


**2 FLOOR DETAIL**  
SCALE: 1 1/2" = 1'-0"

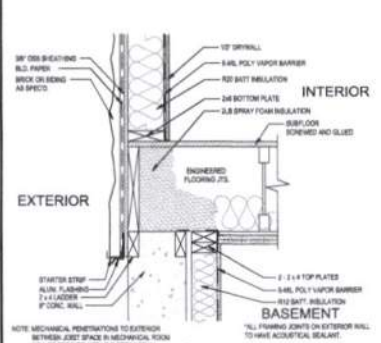


**3 FLOOR DETAIL**  
SCALE: 1 1/2" = 1'-0"

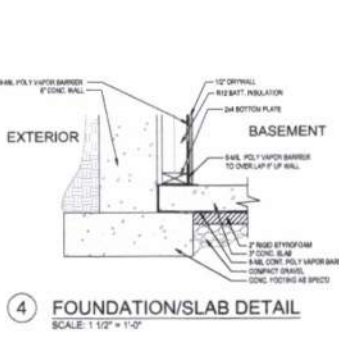


**4 FOUNDATION/SLAB DETAIL**  
SCALE: 1 1/2" = 1'-0"

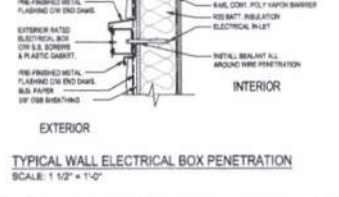

**TYPICAL WALL ELECTRICAL BOX PENETRATION**  
SCALE: 1 1/2" = 1'-0"

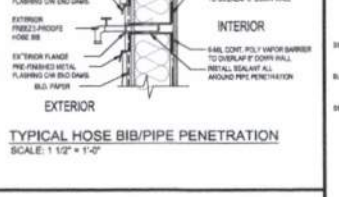


**TYPICAL HOSE BIB/PIPE PENETRATION**  
SCALE: 1 1/2" = 1'-0"

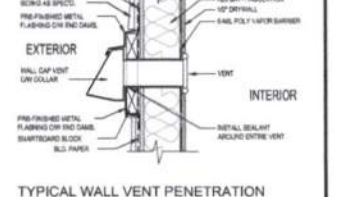


**TYPICAL WALL VENT PENETRATION**  
SCALE: 1 1/2" = 1'-0"


**NATIONAL ENERGY CODE DETAILS**

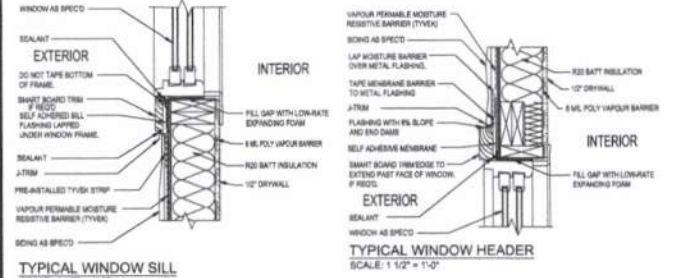

**TYPICAL WINDOW SILL**  
SCALE: 1 1/2" = 1'-0"

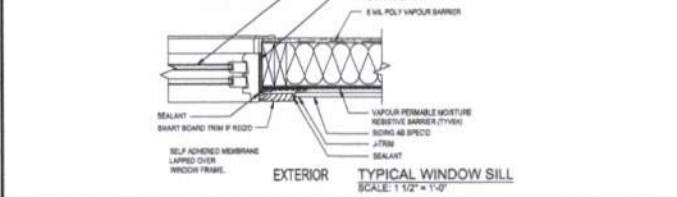

**TYPICAL WINDOW HEADER**  
SCALE: 1 1/2" = 1'-0"

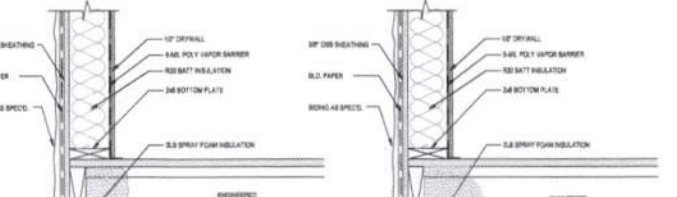

**TYPICAL CANTILEVER DETAIL**  
SCALE: 1 1/2" = 1'-0"



**TYPICAL CANTILEVER DETAIL**  
SCALE: 1 1/2" = 1'-0"

**BUILDING PERMIT**

**PROJECT:**  
438, 8th Street N.E.  
CALGARY, AB

**BRIDGELAND**

**DATE:**  
FEBRUARY 19/2024

**REVISION DATE:**  
March 4-2024 - Revised plans for revised garage  
March 27-2024 - Revised plans for carriage built  
January 31-2025 - Add rail guard in stair window.  
July 4-2025 - Revise as per city safety comments. July 2025  
Nov 23-2025 - Lower Development Plans for BP.

**DRAWN BY:** IW  
**SCALE:** 1/4" = 1'-0"

**MODEL NAME:**  
2-Storey

**CONTACT:**  
KELVIN HICKERSON  
403-463-1429







**PAGE:**  
6 of 7

**REVISIONS:**

**THESE DRAWINGS ARE THE PROPERTY OF THE CONSULTING ENGINEER AND WILL BE RETURNED TO HIM/HER UPON COMPLETION OF THE BUILDING PERMIT PROCESS.**

# NATIONAL ENERGY CODE DETAILS WINDOW INSTALLATION

NOT TO SCALE

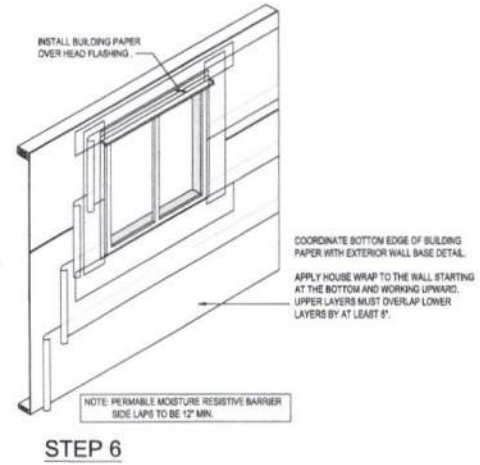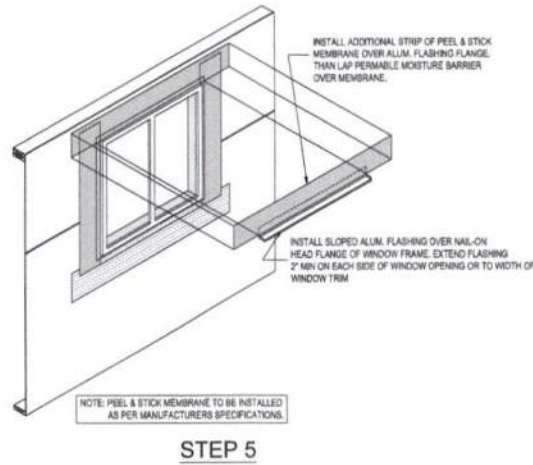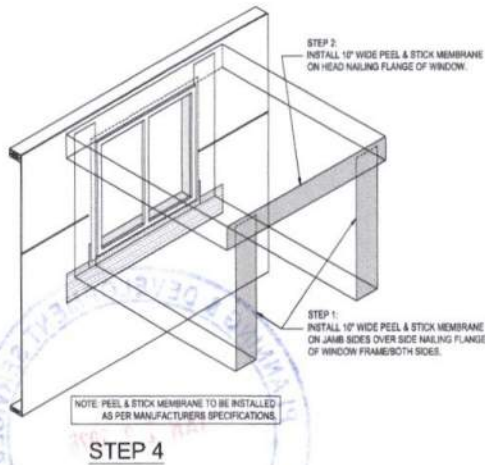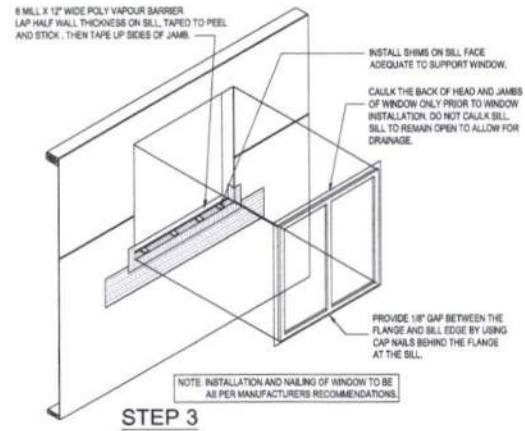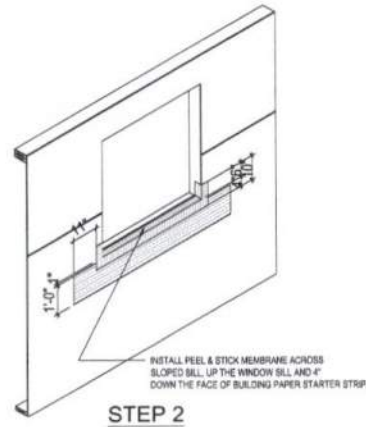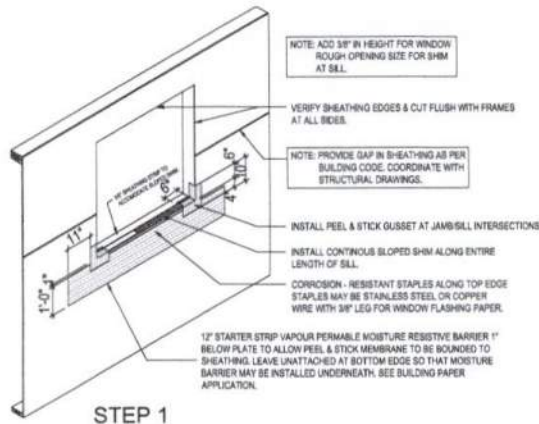

BUILDING PERMIT

STAGE: \_\_\_\_\_  
COMMENTS: \_\_\_\_\_  
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PROJECT:  
438, 8th Street N.E.  
CALGARY, AB

Bridgeland

DATE:  
FEBRUARY 19/2024

REVISION DATE:  
March 4-2024 - Revised plans for reversed garage  
March 27-2024 - Revised plans for carriage bulb.  
January 31-2025 - Adds nail count in steel window.  
July 4-2025 - Revise as per city deficiency comments. July 2025  
Nov 23-2025 - Lower Development Plans for BP.

DESIGNED BY: \_\_\_\_\_  
DRAWN BY: \_\_\_\_\_  
SCALE: 1/4" = 1'-0"

SCALE:  
IW 1/4" = 1'-0"

MODEL NAME:  
2-Storey

CONTACT:  
KELVIN HICKERSON  
403-463-1429

PAGE:  
7 of 7

DP2026-00391

